



FILE NAME: 1.A1.112

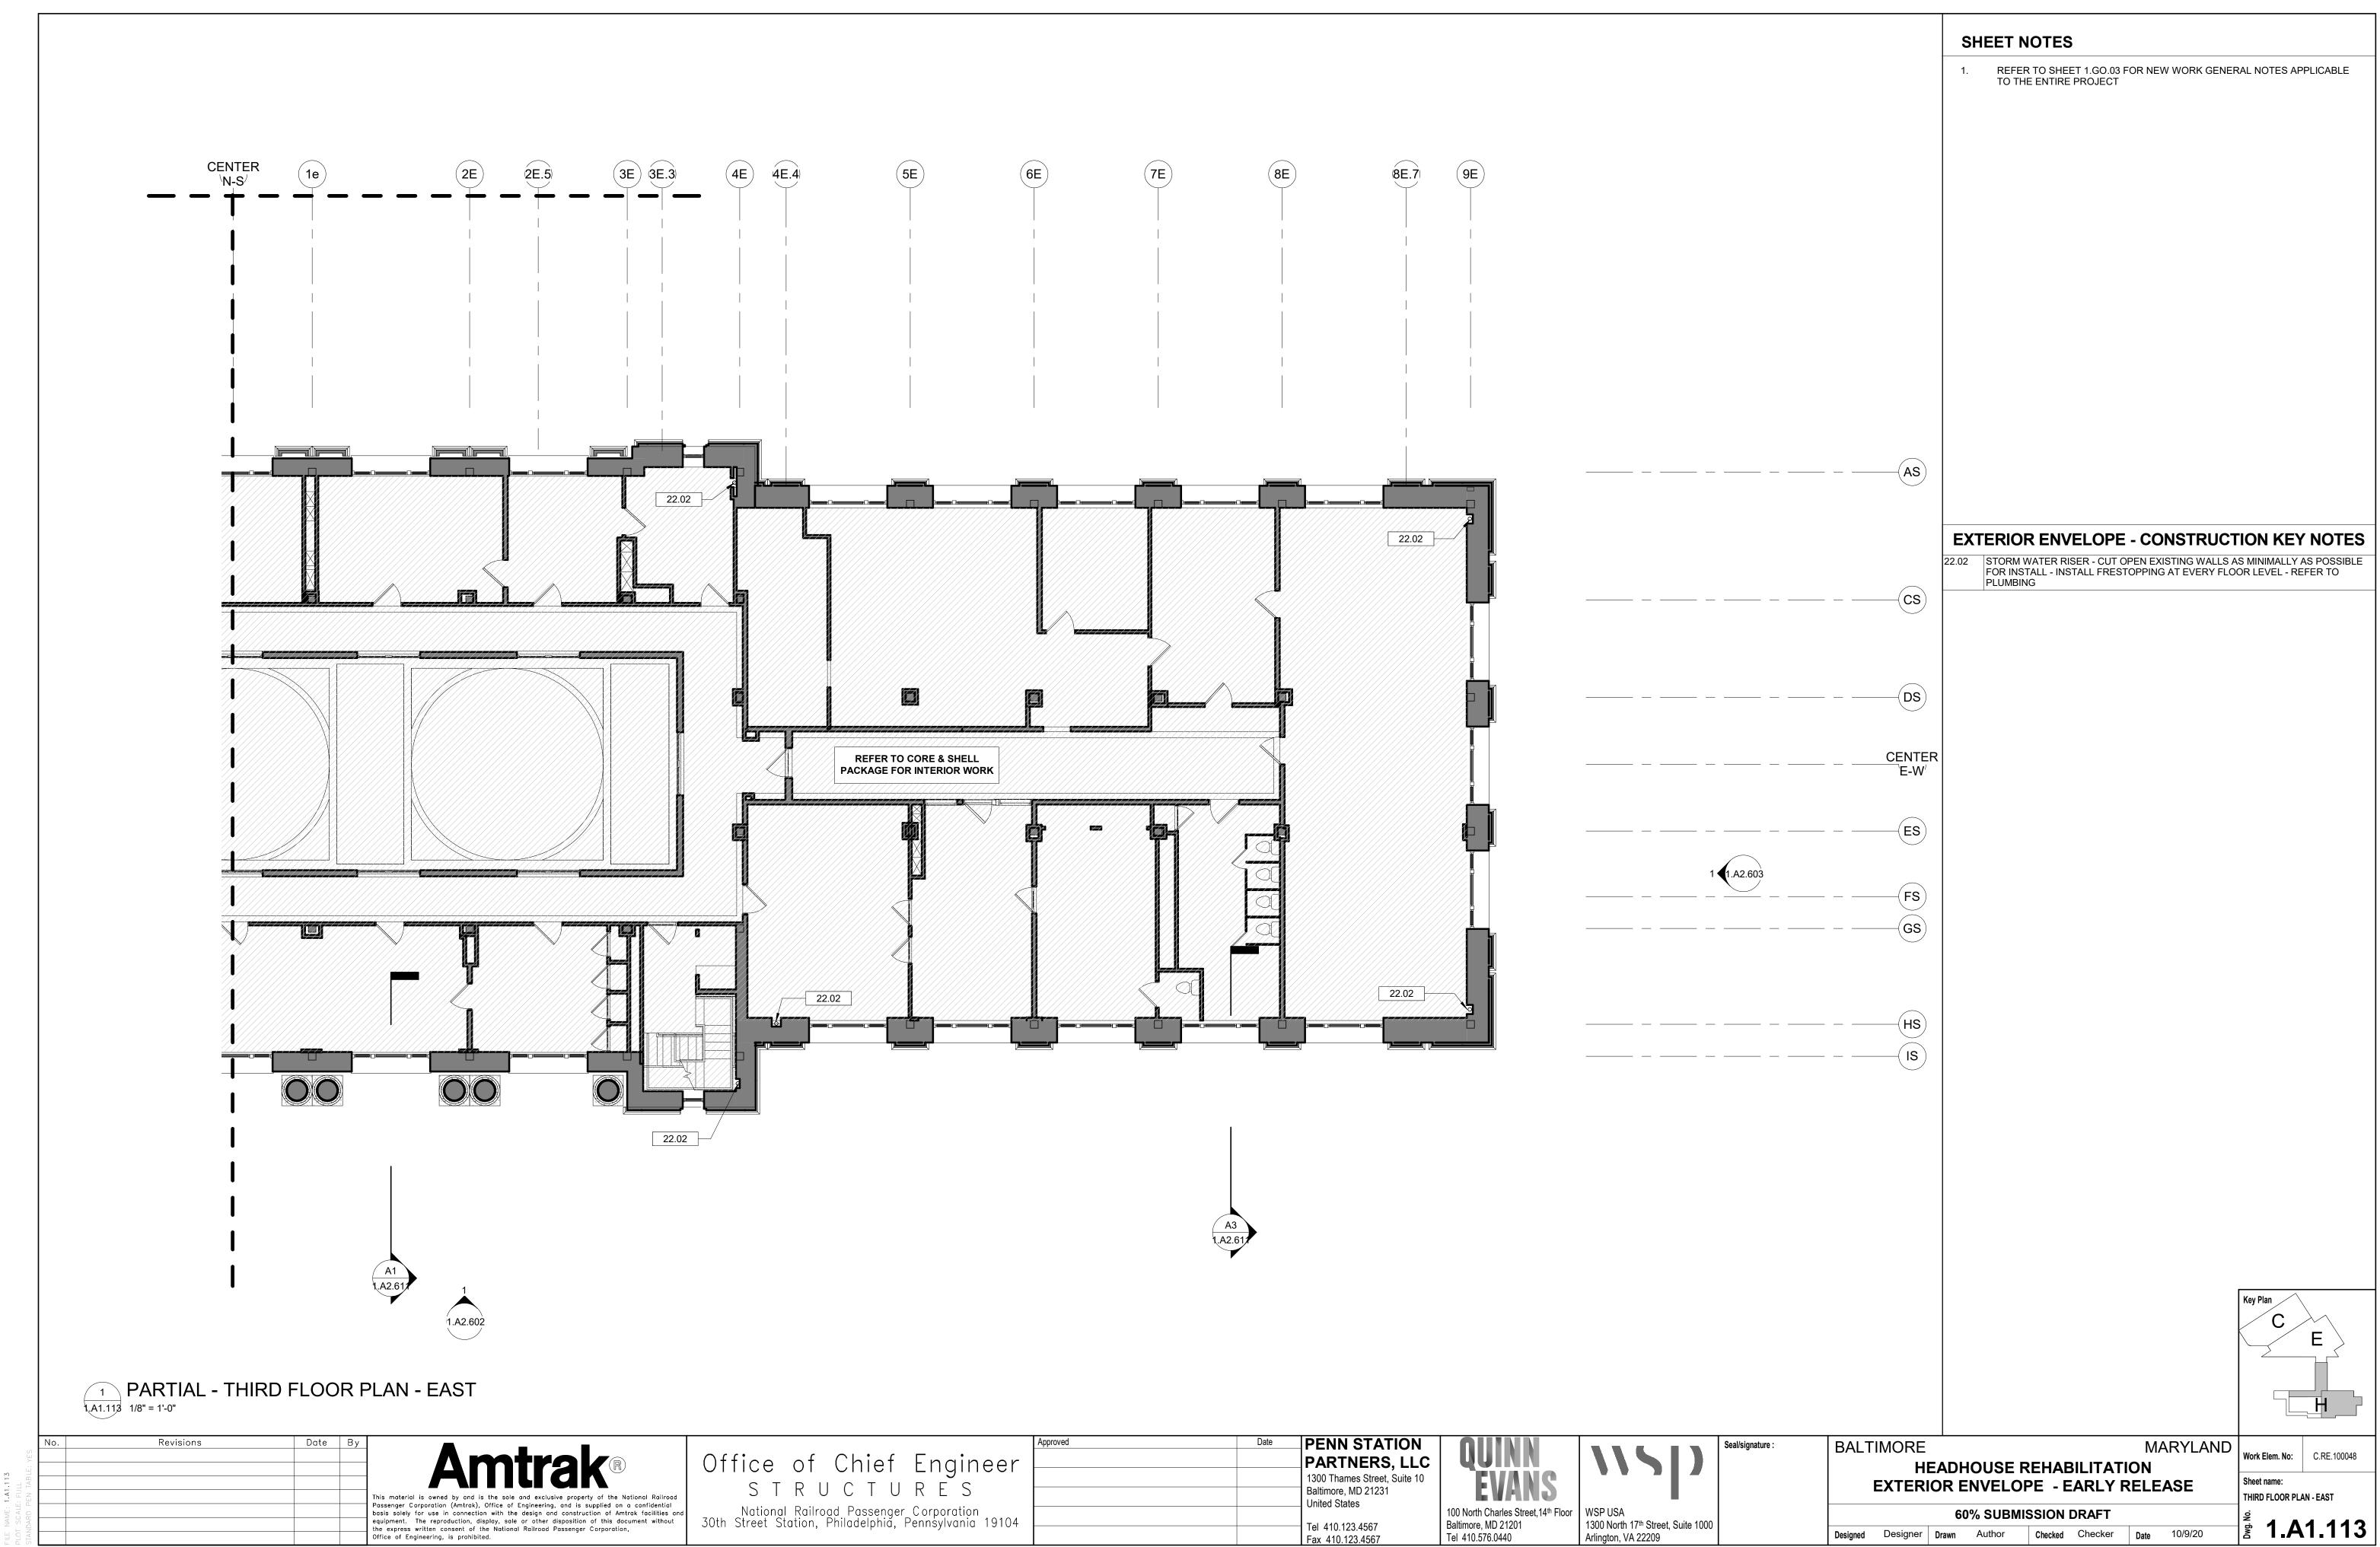

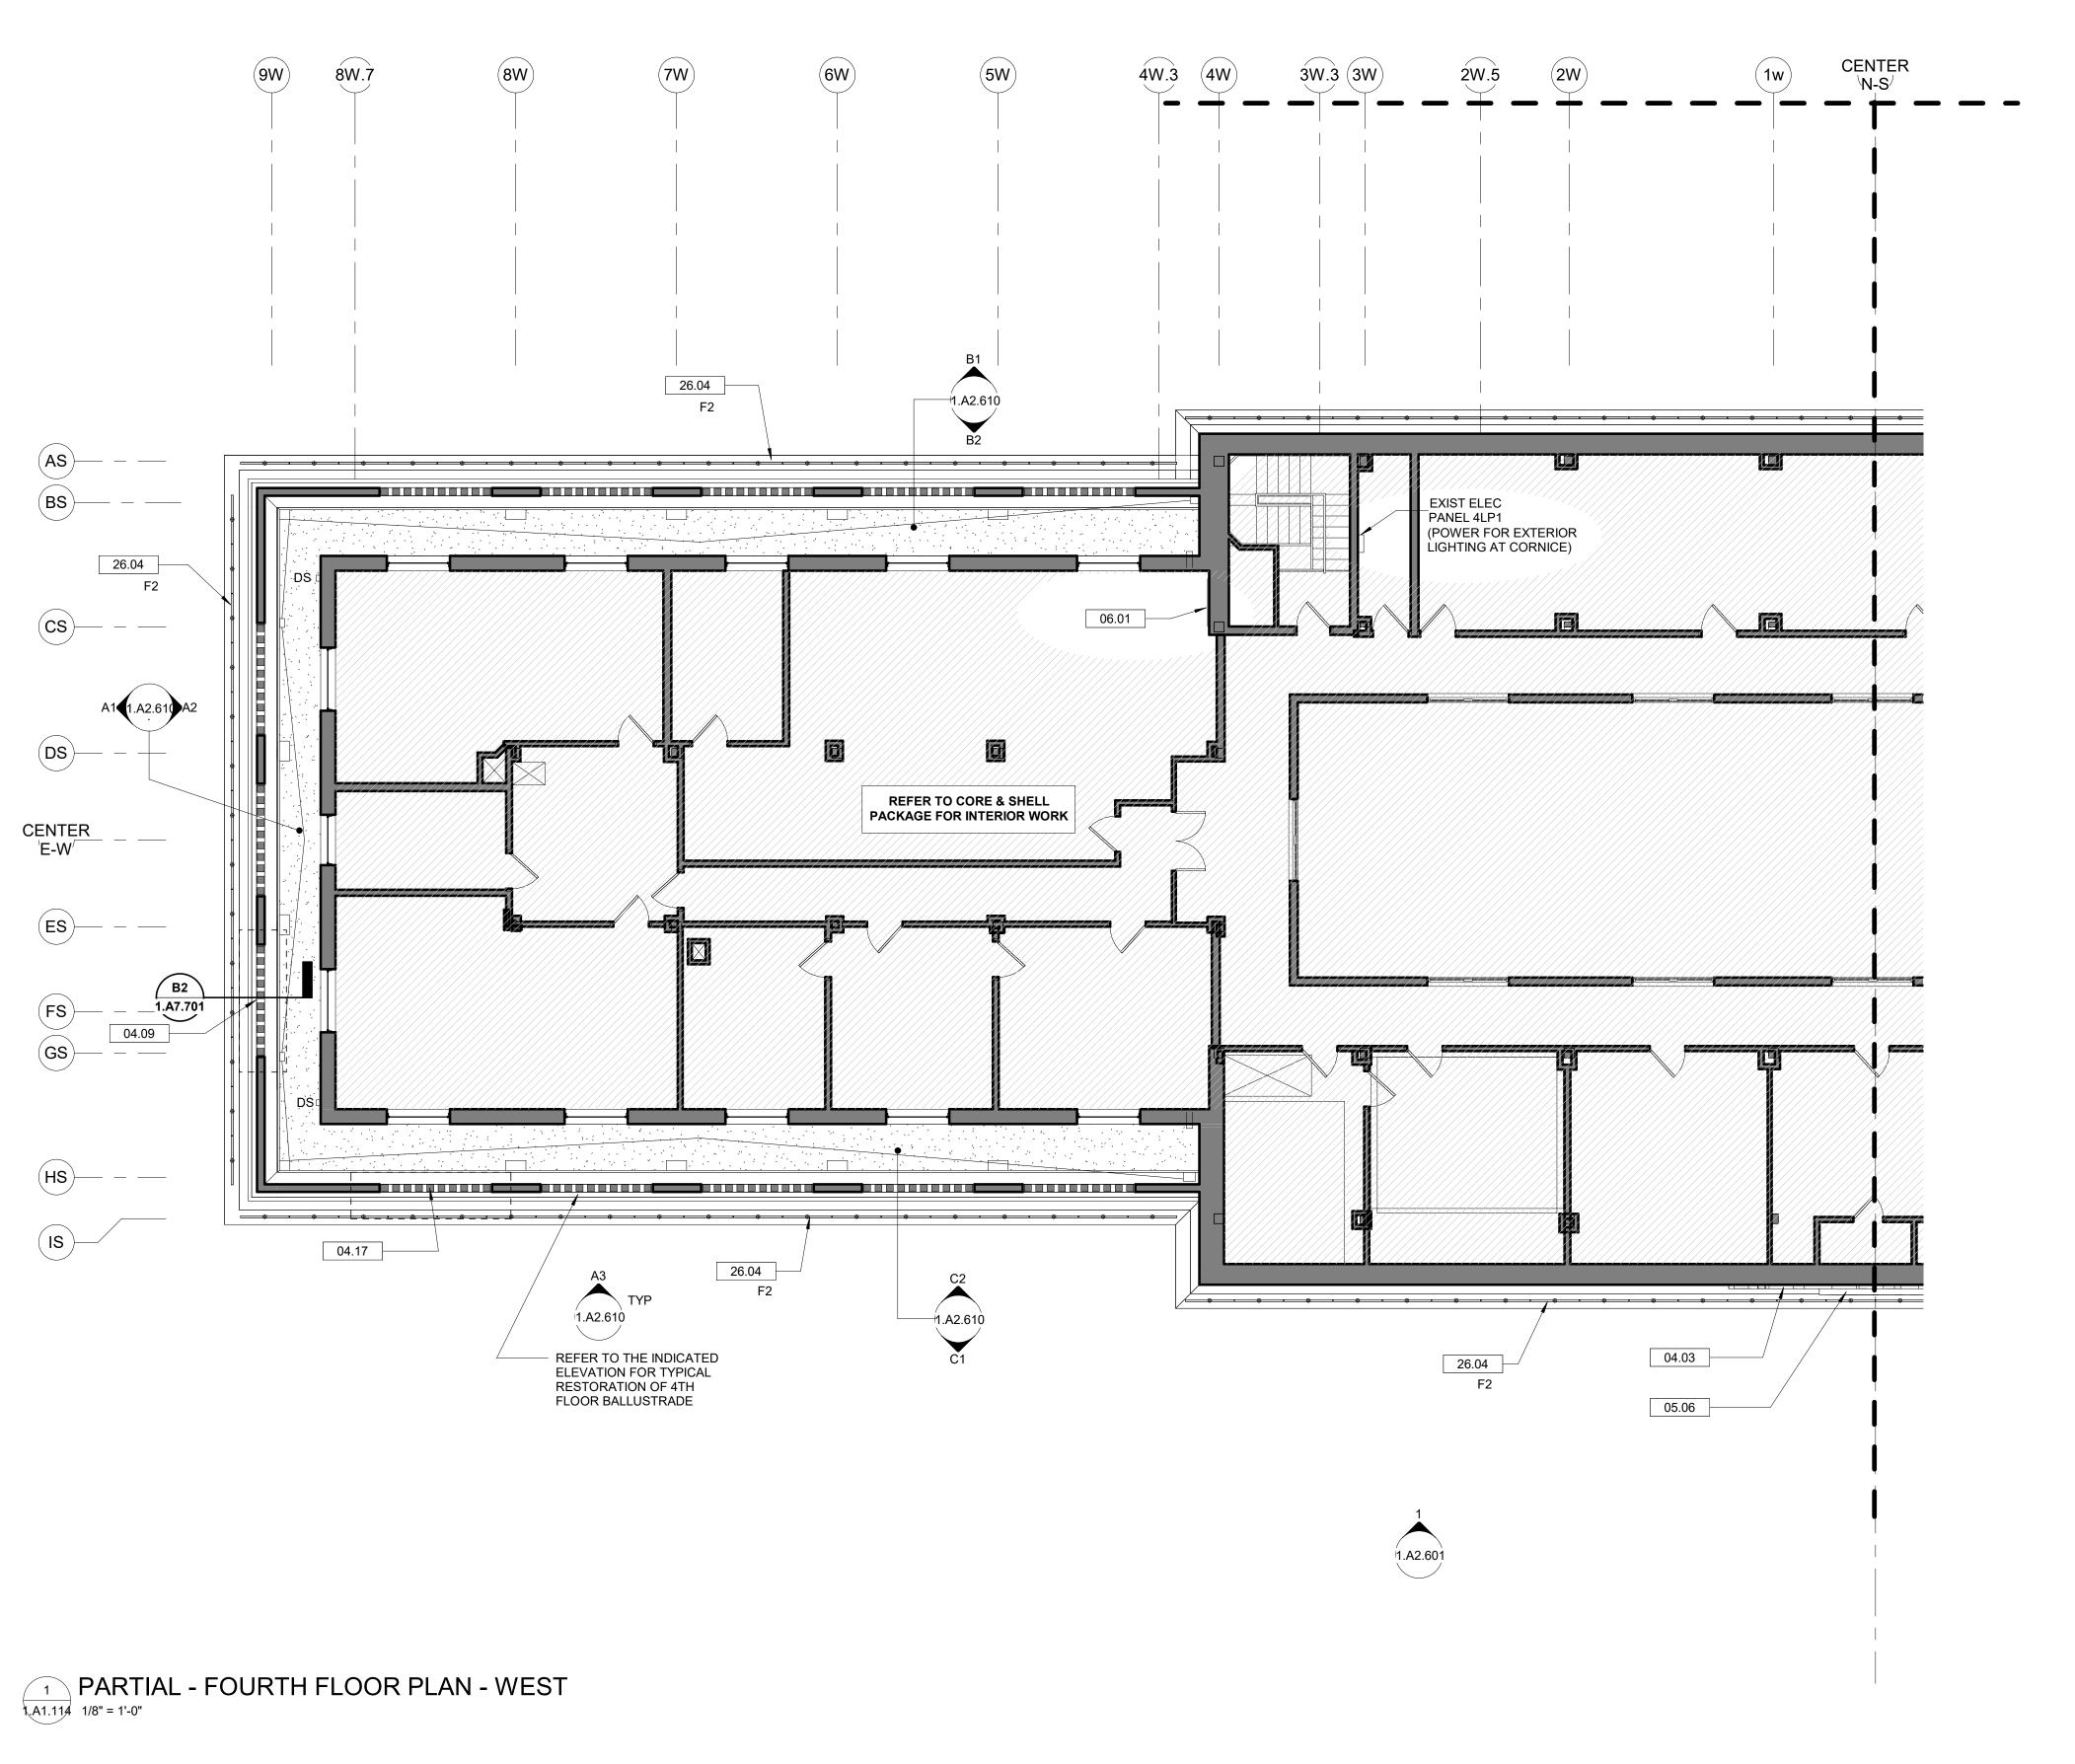

SHEET NOTES

REFER TO SHEET 1.GO.03 FOR NEW WORK GENERAL NOTES APPLICABLE TO THE ENTIRE PROJECT

EXTERIOR ENVELOPE - CONSTRUCTION KEY NOTES

04.03 CLEAN, REPAIR & REPOINT GRANITE SCULPTURE PER SPECIFICATIONS 04.09 REMOVE DISLOCATED GRANITE CAPSTONE AND CABLE SUPPORTS. REINFORCE BY RESETTING WITH STRUCTURAL STEEL PINS (REFER TO DETAIL INDICATED). REPLACE BROKEN BALUSTER WITH STONE BALUSTER TO MATCH EXISTING. RAKE OUT AND REPOINT ALL MORTAR JOINTS WITHIN SECTION OF BALUSTRADE.

04.17 REMOVE DISLOCATED GRANITE CAPSTONE. REINFORCE BY RESETTING WITH STEEL PINS (REFER TO DETAIL INDICATED)

05.06 CLOCK. CLEAN AND REFURBISH

06.01 PROVIDE 4-FOOT W x 8-FOOT H PLYWOOD BACKER PANEL FOR MOUNTING EXTERIOR LIGHTING CONTROL EQUIPMENT. PROVIDE POWER AS DESCRIBED BY ELECTRICAL ENGINEER

26.04 EXTERIOR LIGHTING FIXTURES MOUNTED END TO END AT CORNICE - TYP

Work Elem. No: C.RE.100048

Revisions EE 60% Draft — add of elec panels \$\frac{9}{23}/20 Passenger Corporation (Amtrak), Office of Engineering, and is supplied on a confidential basis solely for use in connection with the design and construction of Amtrak facilities and equipment. The reproduction, display, sale or other disposition of this document without the express written consent of the National Railroad Passenger Corporation, Office of Engineering, is prohibited.

Office of Chief Engineer STRUCTURES National Railroad Passenger Corporation 30th Street Station, Philadelphia, Pennsylvania 19104

PENN STATION PARTNERS, LLC 1300 Thames Street, Suite 10 Baltimore, MD 21231 United States Tel 410.123.4567 Fax 410.123.4567

100 North Charles Street,14th Floor Baltimore, MD 21201

Tel 410.576.0440

1300 North 17th Street, Suite 1000


Arlington, VA 22209

BALTIMORE


MARYLAND **HEADHOUSE REHABILITATION EXTERIOR ENVELOPE - EARLY RELEASE**

Sheet name: 4TH FLOOR PLAN - WEST

60% SUBMISSION DRAFT 1.A1.114 Designed Designer Drawn Author Checked Checker Date 10/9/20

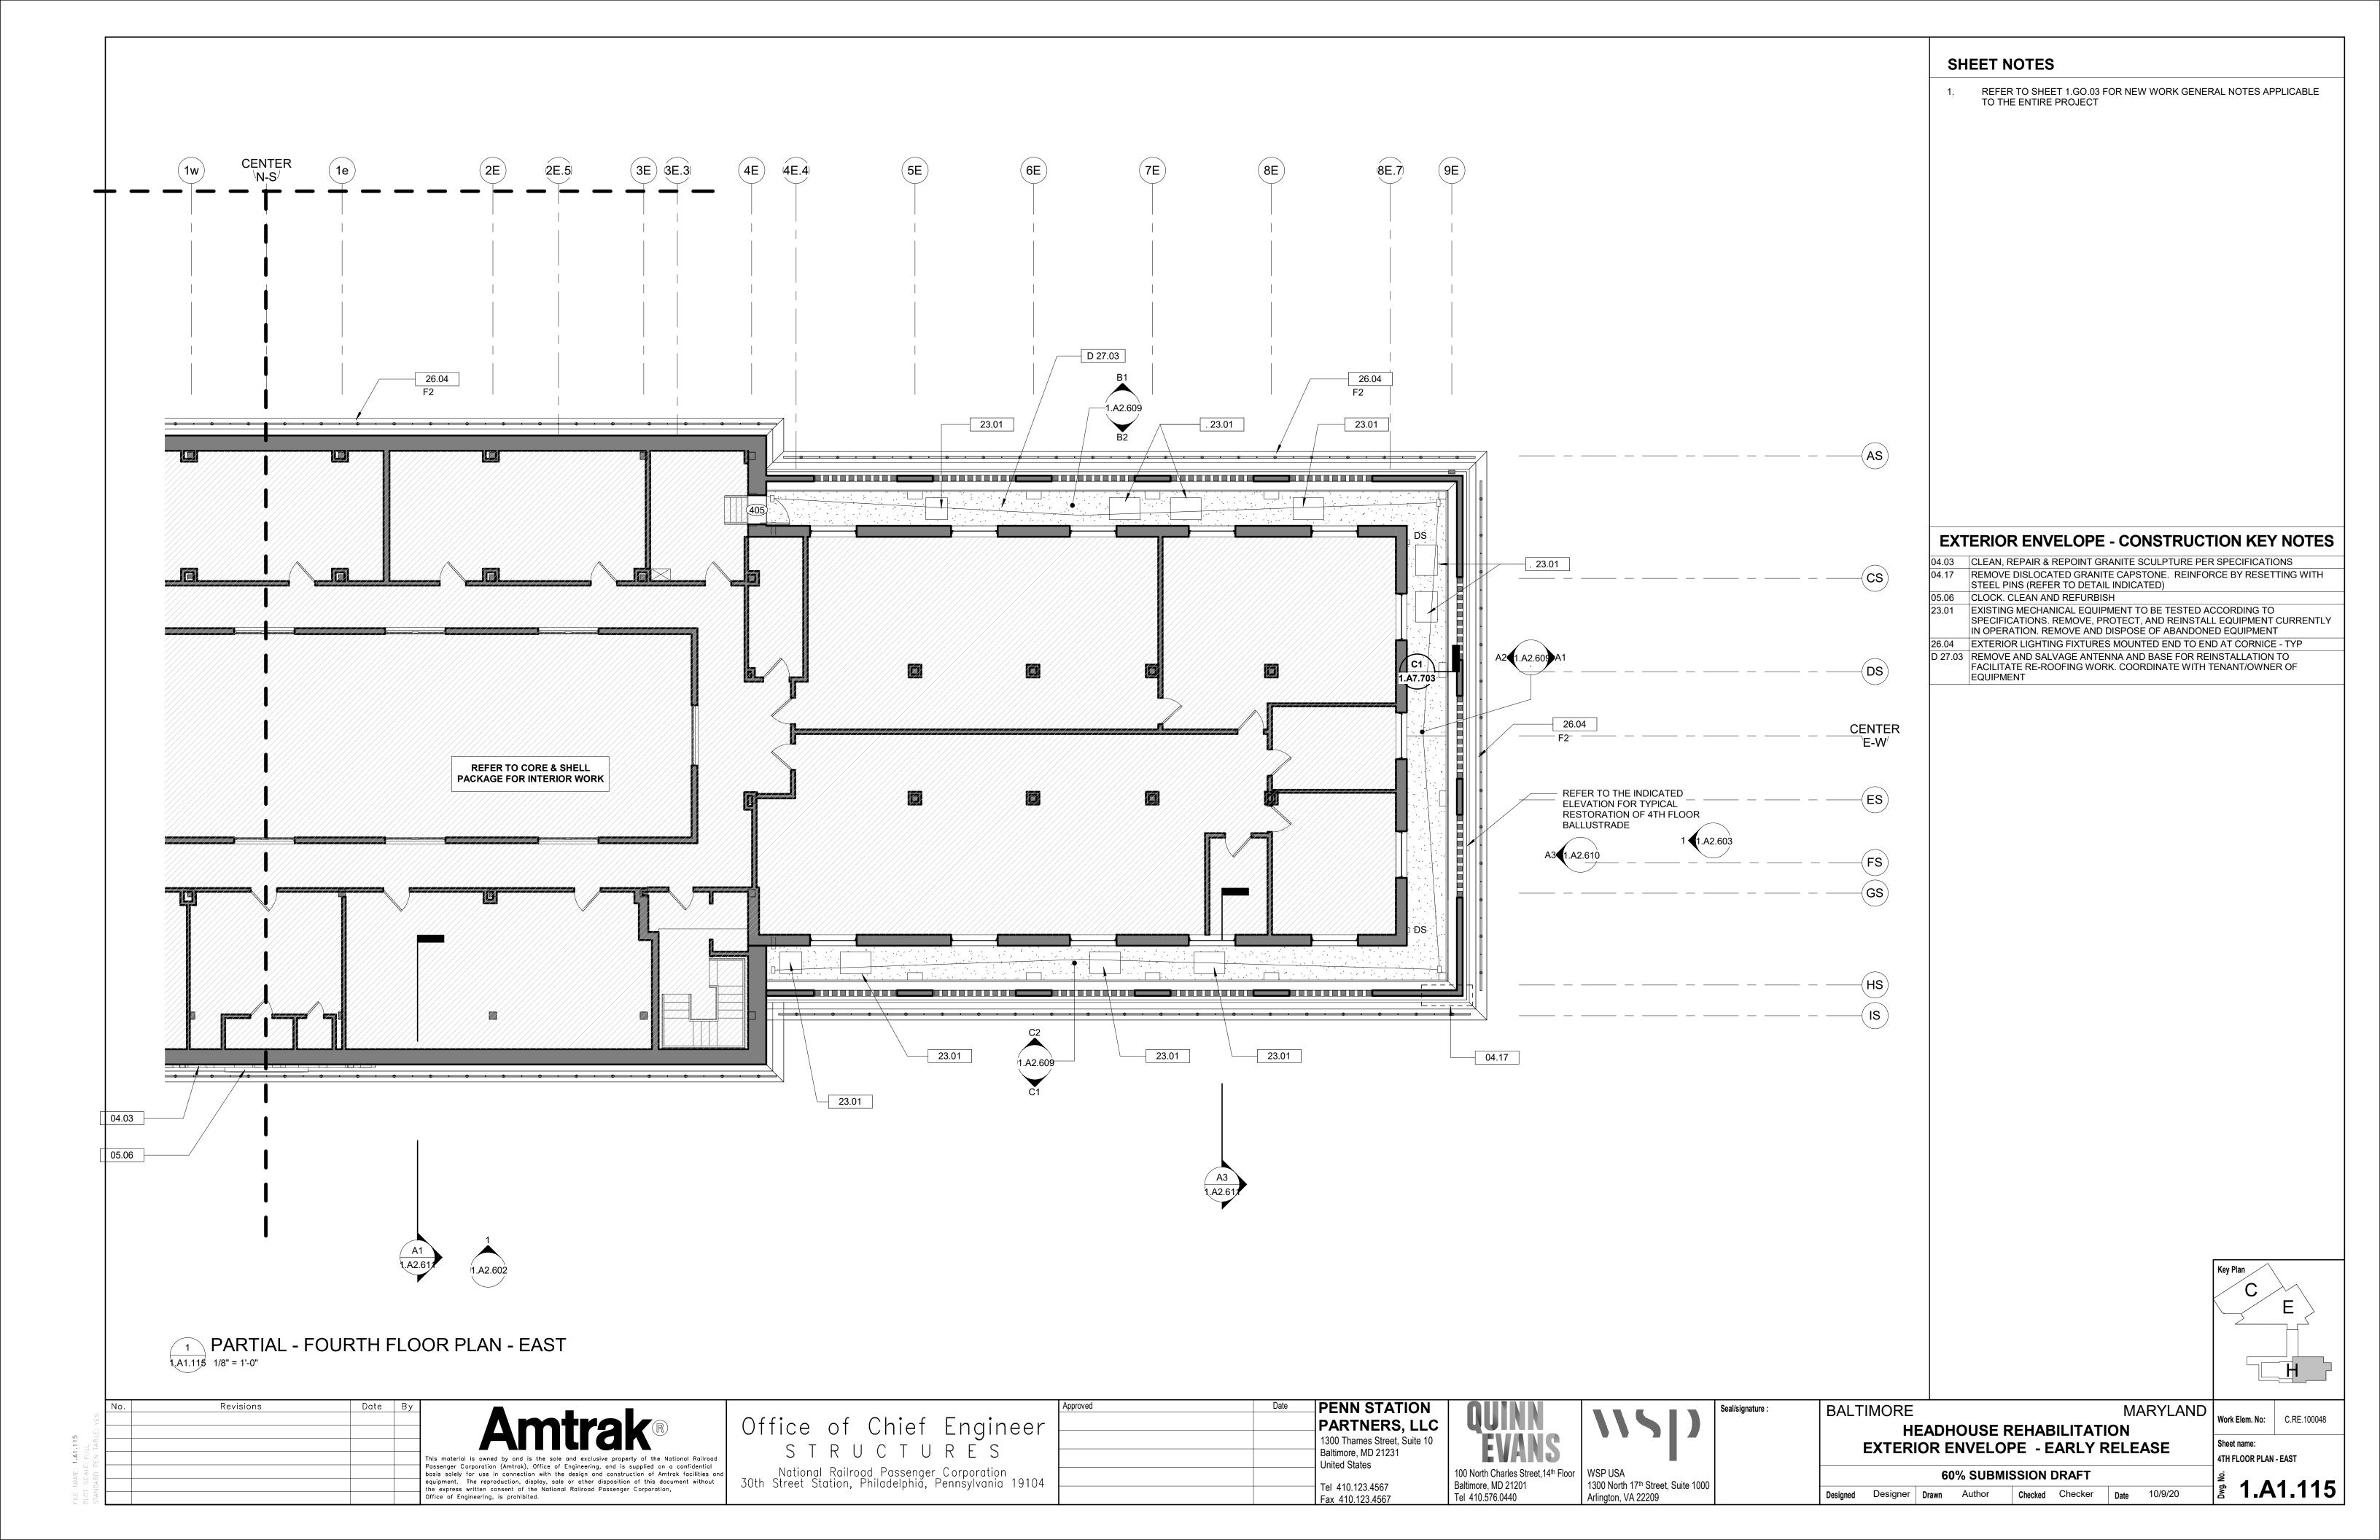

*ASSUME 10% (1,188 SF) OF T.O. EXISTING ROOF DECK (CONCRETE TOPPING) WILL NEED TO BE REPAIRED PRIOR TO INSTALLATION OF NEW INSULATION AND ROOFING, CONTRACTOR TO VERIFY CONDITIONS AND EXTENT IN FIELD FOLLOWING REMOVAL OF EXISTING ROOFING AND EXPOSURE OF DECK.

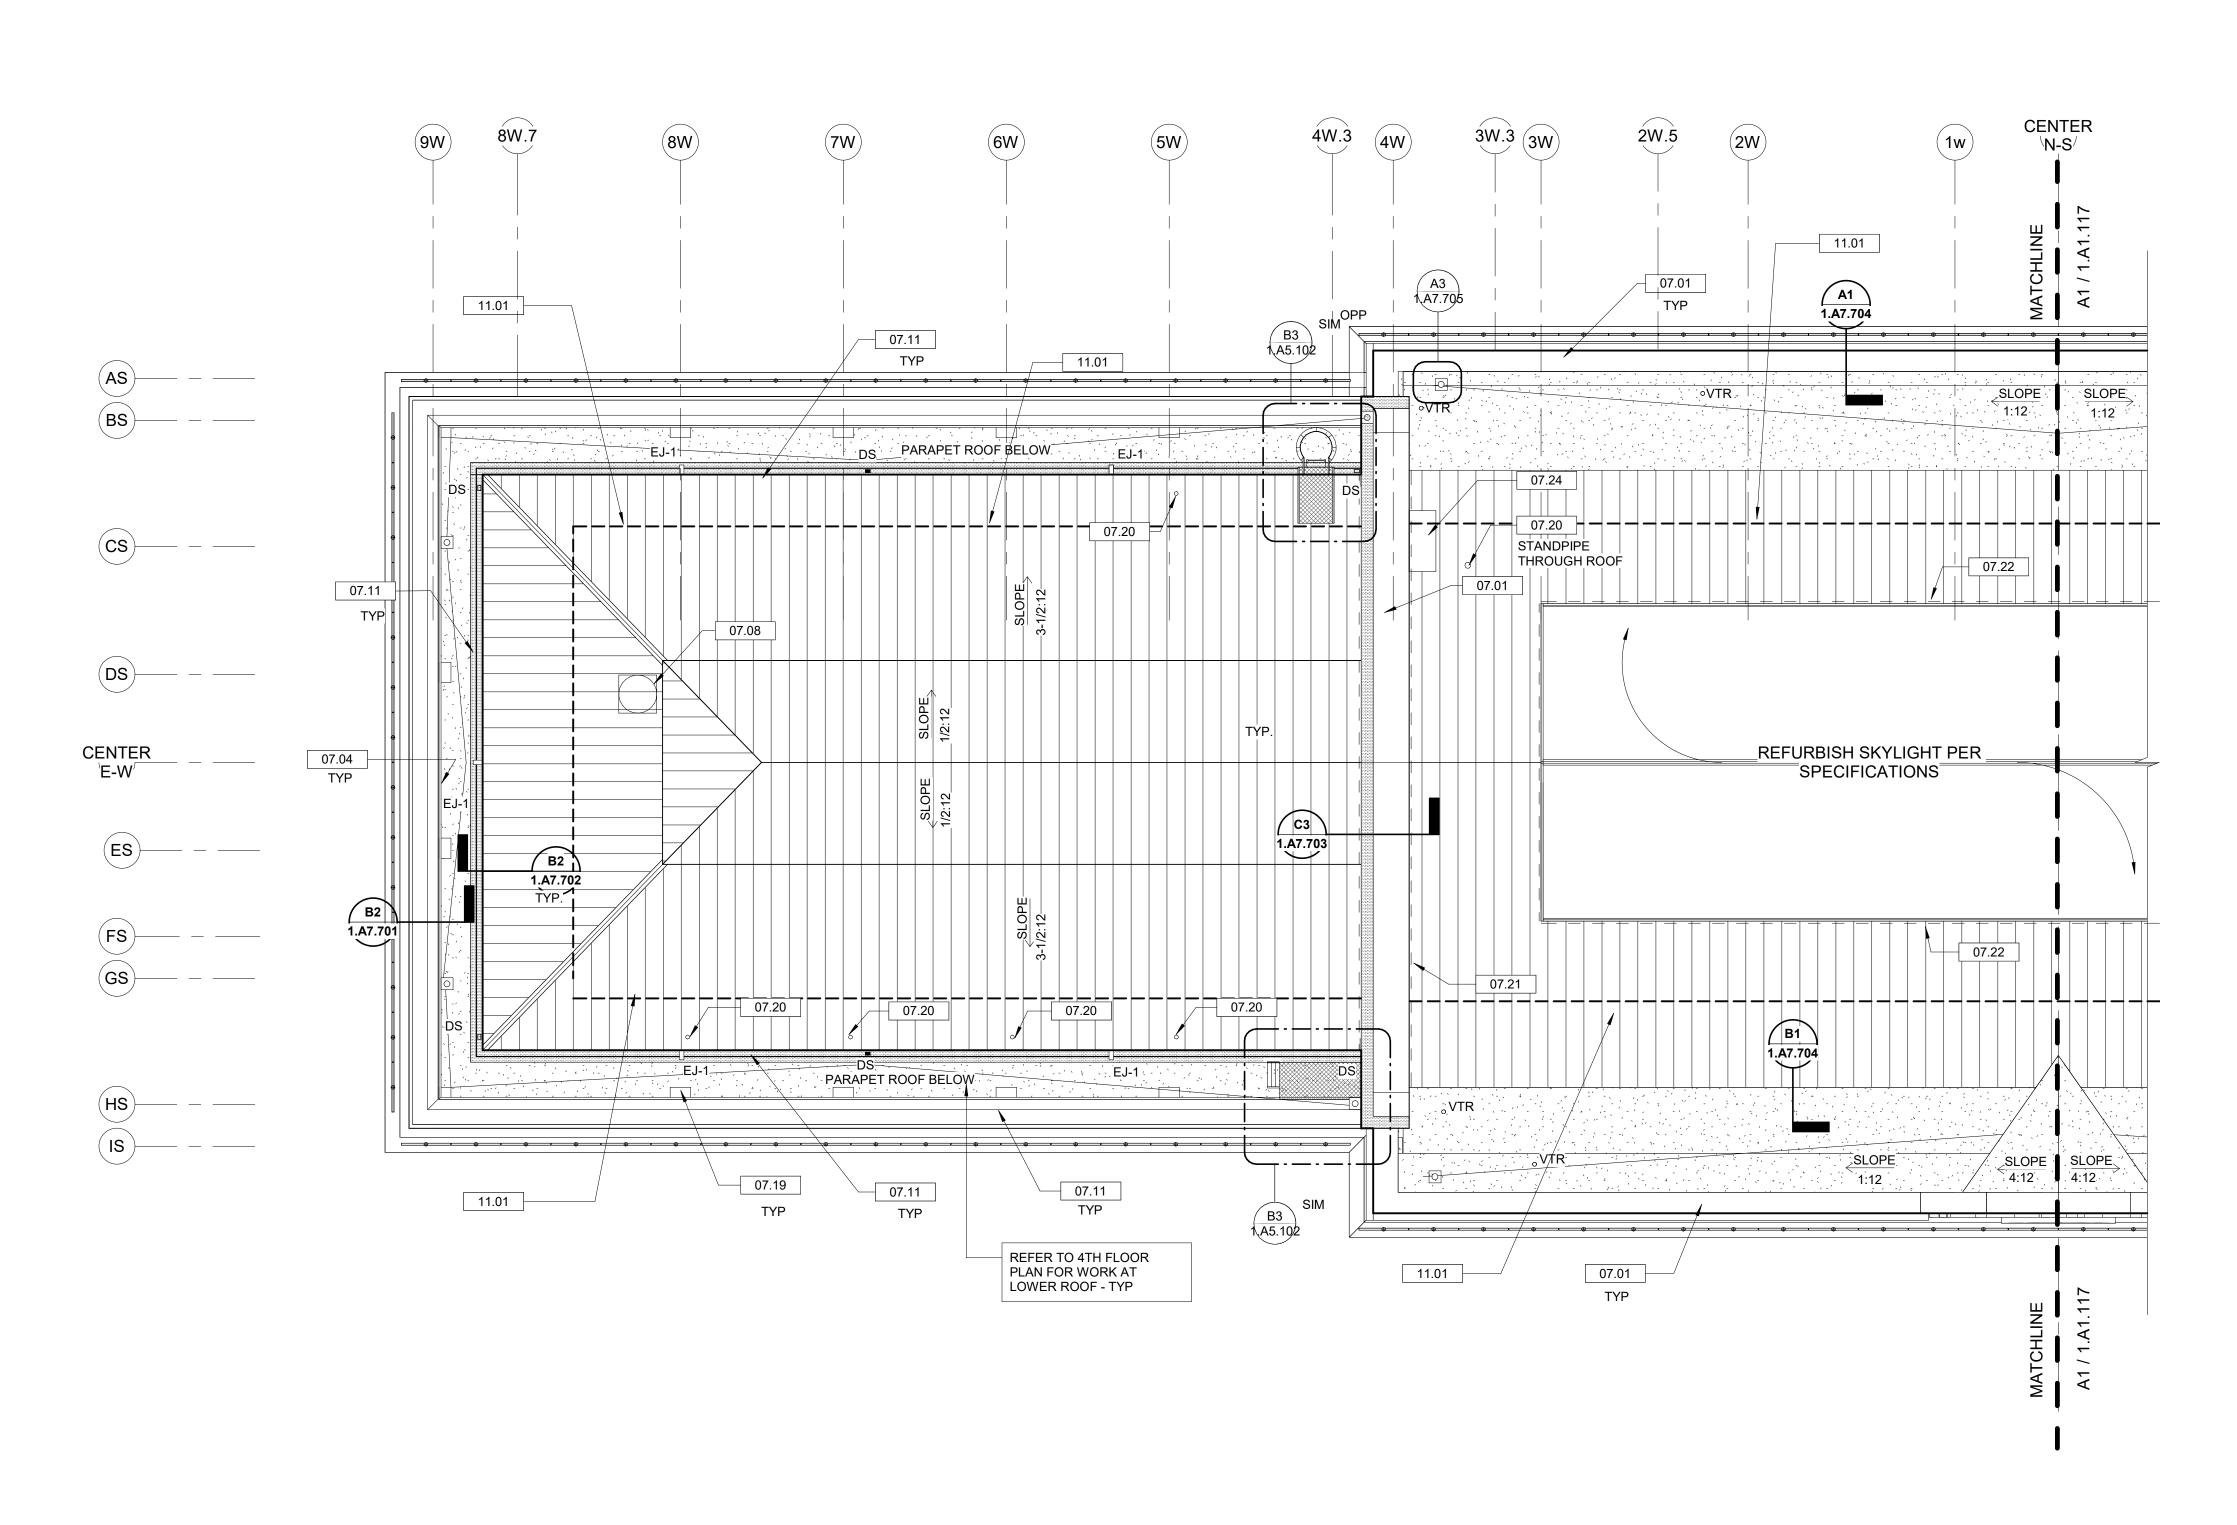

PARTIAL UPPER ROOF PLAN - WEST 1.A1.116 1/8" = 1'-0"

- LOCATION NUMBER

CD-1 EXISTING COMMUNICATION DEVICE TO

H

BALTIMORE MARYLAND **HEADHOUSE REHABILITATION EXTERIOR ENVELOPE - EARLY RELEASE**

SHEET NOTES

REFER TO DETAIL.

UPPER ROOF LEGEND

BE REFURBISHED

ROOFS TO REMAIN

TO THE ENTIRE PROJECT

DELEGATED DESIGN SYSTEM AS FOLLOWS:

AUXILIARY BYPASS LANYARD

SAG BETWEEN TWO ANCHORS.

REFER TO SHEET 1.GO.03 FOR NEW WORK GENERAL NOTES APPLICABLE

PROVIDE A HANDS FREE HORIZONTAL LIFELINE SYSTEM ABLE TO ACCOMMODATE USE WITH STANDARD HARNESS AND J-CLAMP

WHEN WEARING A BODY HARNESS WITH A SAFETY FACTOR OF 2 WITHOUT PERMANENT DEFORMATION, AND 5,000 POUNDS

ACCOMMODATE A CAPACITY MAXIMUM OF 2 WORKERS PER

PROVIDE ALL TURNBUCKLES, J-CLAMPS, THIMBLES, AND SHOCK ABSORBERS REQUIRED FOR COMPLETE CONTINUOUS

CABLE SYSTEM THRU ANCHORS, AS SHOWN. PROVIDE

ANCHOR LAYOUT AND SPACING IS TO ACCOMMODATE STANDARD LANYARD LENGTHS (WITH 12 FT. EXTENSION LANYARDS AT CONCOURSE ROOF, AND ROBE GRAB

TO ALL ROOF SURFACES AND EDGES, INCLUDING ALL

COMPLY WITH OSHA AND OTHER AUTHORITIES HAVING

EXTERIOR ENVELOPE - CONSTRUCTION KEY NOTES

07.01 PROVIDE NEW CONTINUOUS METAL COPING CAP TO MATCH EXISTING PROFILE -

07.08 | RE-INSTALL SALVAGED MECHANICAL VENT HOOD OVER NEW BASE FLASHING

07.19 PROVIDE NEW METAL COPING CAP AT TOP OF EXISTING BRICK COLUMN WRAP -

07.24 CURB AND COVER OVER ABANDONED SKYLIGHT TO REMAIN - REPAIR FLASHINGS

SYSTEM IS TO BE BID AS A DESIGN-BUILD, DELEGATED DESIGN SYSTEM. REFER

TO SHEET NOTE 1 ON CONCOURSE AND UPPER ROOF PLANS FOR MORE DETAIL

EXISTING TERNE-COATED STAINLESS STEEL STANDING SEAM ROOF TO

PROVIDE NEW, FULLY-ADHERED 90-MIL EPDM ROOF SYSTEM ON COVER

BOARD, OVER ADHERED 4" MIN. RIGID INSULATION BOARD, TAPERED &

ROOF DRAIN - PROVIDE NEW ROOF DRAIN AT EXISTING DRAIN LOCATION. ENLARGE CORE HOLE THRU DECK TO ACCOMMODATE LARGER PIPE

DIAMETER. REFER TO PLUMBING. FLASH NEW ROOF SYSTEM INTO NEW

EXISTING VENT THRU ROOF, PROVIDE WITH NEW PRE-MANUFACTURED EPDM PIPE FLASHING BOOT AROUND EXISTING VENT PIPE TO REMAIN AT

NEW EPDM ROOFS. REPAIR OR REPLACE FLASHING AT EXISTING METAL

NEW 3"X5" MILL DOWNSPOUT, EXTENDING 1-STORY DOWN FROM BUILT IN GUTTER AND DAYLIGHTING ONTO 4TH FLOOR PARAPET BELOW, IN

SAME LOCATION AS EXISTING. REPLICATE EXISTING CONDUCTOR BOX.

PROVIDE NEW DOWNSPOUT STRAPS TO MATCH EXISTING IN QUANTITY AND LOCATION - FASTEN THRU MORTAR JOINTS ONLY. REFER TO

NEW 3"X5" DOWNSPOUT, EXTENDING 1-STORY DOWN FROM BUILT IN GUTTER AND DAYLIGHTING ONTO 4TH FLOOR PARAPET BELOW, IN NEW LOCATION AS SHOWN. CORE THRU AND PASS NEW DOWNSPOUT THRU EXISTING CORNICE TO MATCH ADJACENT/EXISTING DOWNSPOUT DETAILING. PROVIDE NEW CONDUCTOR BOX TO REPLICATE ADJACENT EXISTING BOXES. REFER TO C1/1.A7.702 FOR DS OUTLET DETAIL.

NEW GUTTER EXPANSION JOINT - REFER TO TYPICAL DETAIL.

11.01 PROVIDE FALL PROTECTION INFRASTRUCTURE AS REQUIRED. COMPLETE

07.21 REPAIR OR REPLACE DAMAGED OR CORRODED BASE FLASHING AND

07.22 REPAIR OR REPLACE DAMAGED OR CORRODED BASE FLASHING AND

SLOPED TO DRAINS, OVER EXISTING ROOF DECK.

SLOPE DIRECTION OF ROOF SLOPE - DOWN TO DRAIN.

DRAIN BODIES - REFER TO A3/1.A7.705.

C1/1.A7.702 FOR DS OUTLET DETAIL.

PROVIDE NEW GUTTER LINING (SLOPED TO DRAINS) OVER WATERPROOFING

EXISTING. VERIFY EXIST. DETAILING TO BE DETERMINED FOLLOWING FIELD

UNDERLAYMENT, IN EXISTING BUILT-IN STONE OR CONCRETE GUTTER TO MATCH

REPAIR OR REPLACE DAMAGED OR CORRODED FLASHING AT PIPE PENETRATION

JURISDICTION REQUIREMENTS. AS PART OF DESIGN-BUILD SUBMISSION, SHOP DRAWINGS SHALL BE MADE WITH

CONNECTING SECTIONS / LEVELS OF ROOFS.

CERTIFICATIONS AND ENGINEER'S SEAL

07.04 PROVIDE NEW CONT METAL COPING CAP - REFER TO DETAIL

AND WATERPROOFING UNDERLAYMENT.

COUNTERFLASHING EACH SIDE OF PARAPET

COUNTERFLASHING AT SKYLIGHT CURB

ANCHOR AND CABLE SYSTEM WITH 2"-6" MAXIMUM CABLE

PROVIDE PERMANENT ANCHORS FASTENED TO BUILDING STRUCTURE AS NOTED AND DIAGRAMMED. FALL PROTECTION

EXTENSION SYSTEM AT UPPER ROOFS), AND PROVIDE REACH

LENGTHS OF GUTTERS, DRAINS, AND EQUIPMENT, AS WELL AS ALLOW TRAVEL TO ROOF ACCESS STAIRS AND LADDERS

FALL PROTECTION INFRASTRUCTURE IS TO BE BID AS A DESIGN-BUILD,

MAXIMUM FALL ARREST FORCE: 1,800 POUNDS (816 KG)

EQUIPMENT, INCLUDING DOUBLE-LANYARDS AND

(2267 KG) AGAINST FRACTURE OR DETACHMENT

LENGTH OF CABLE BETWEEN TWO ANCHORS.

Sheet name: **ROOF PLAN - WEST**

Office of Chief Engineer STRUCTURES National Railroad Passenger Corporation 30th Street Station, Philadelphia, Pennsylvania 19104

PENN STATION PARTNERS, LLC 1300 Thames Street, Suite 10 Baltimore, MD 21231 United States

100 North Charles Street, 14th Floor Baltimore, MD 21201

Tel 410.576.0440

Work Elem. No: C.RE.100048

Revisions Passenger Corporation (Amtrak), Office of Engineering, and is supplied on a confidential basis solely for use in connection with the design and construction of Amtrak facilities and equipment. The reproduction, display, sale or other disposition of this document without the express written consent of the National Railroad Passenger Corporation, Office of Engineering, is prohibited.

Tel 410.123.4567 Fax 410.123.4567


1300 North 17th Street, Suite 1000 Arlington, VA 22209

60% SUBMISSION DRAFT Designed Designer Drawn Author Checked Checker Date 10/9/20

REMAIN

1.A1.116

*ASSUME 10% (1,188 SF) OF T.O. EXISTING ROOF DECK (CONCRETE TOPPING) WILL NEED TO BE REPAIRED PRIOR TO INSTALLATION OF NEW INSULATION AND ROOFING, CONTRACTOR TO VERIFY CONDITIONS AND EXTENT IN FIELD FOLLOWING REMOVAL OF EXISTING ROOFING AND EXPOSURE OF DECK.

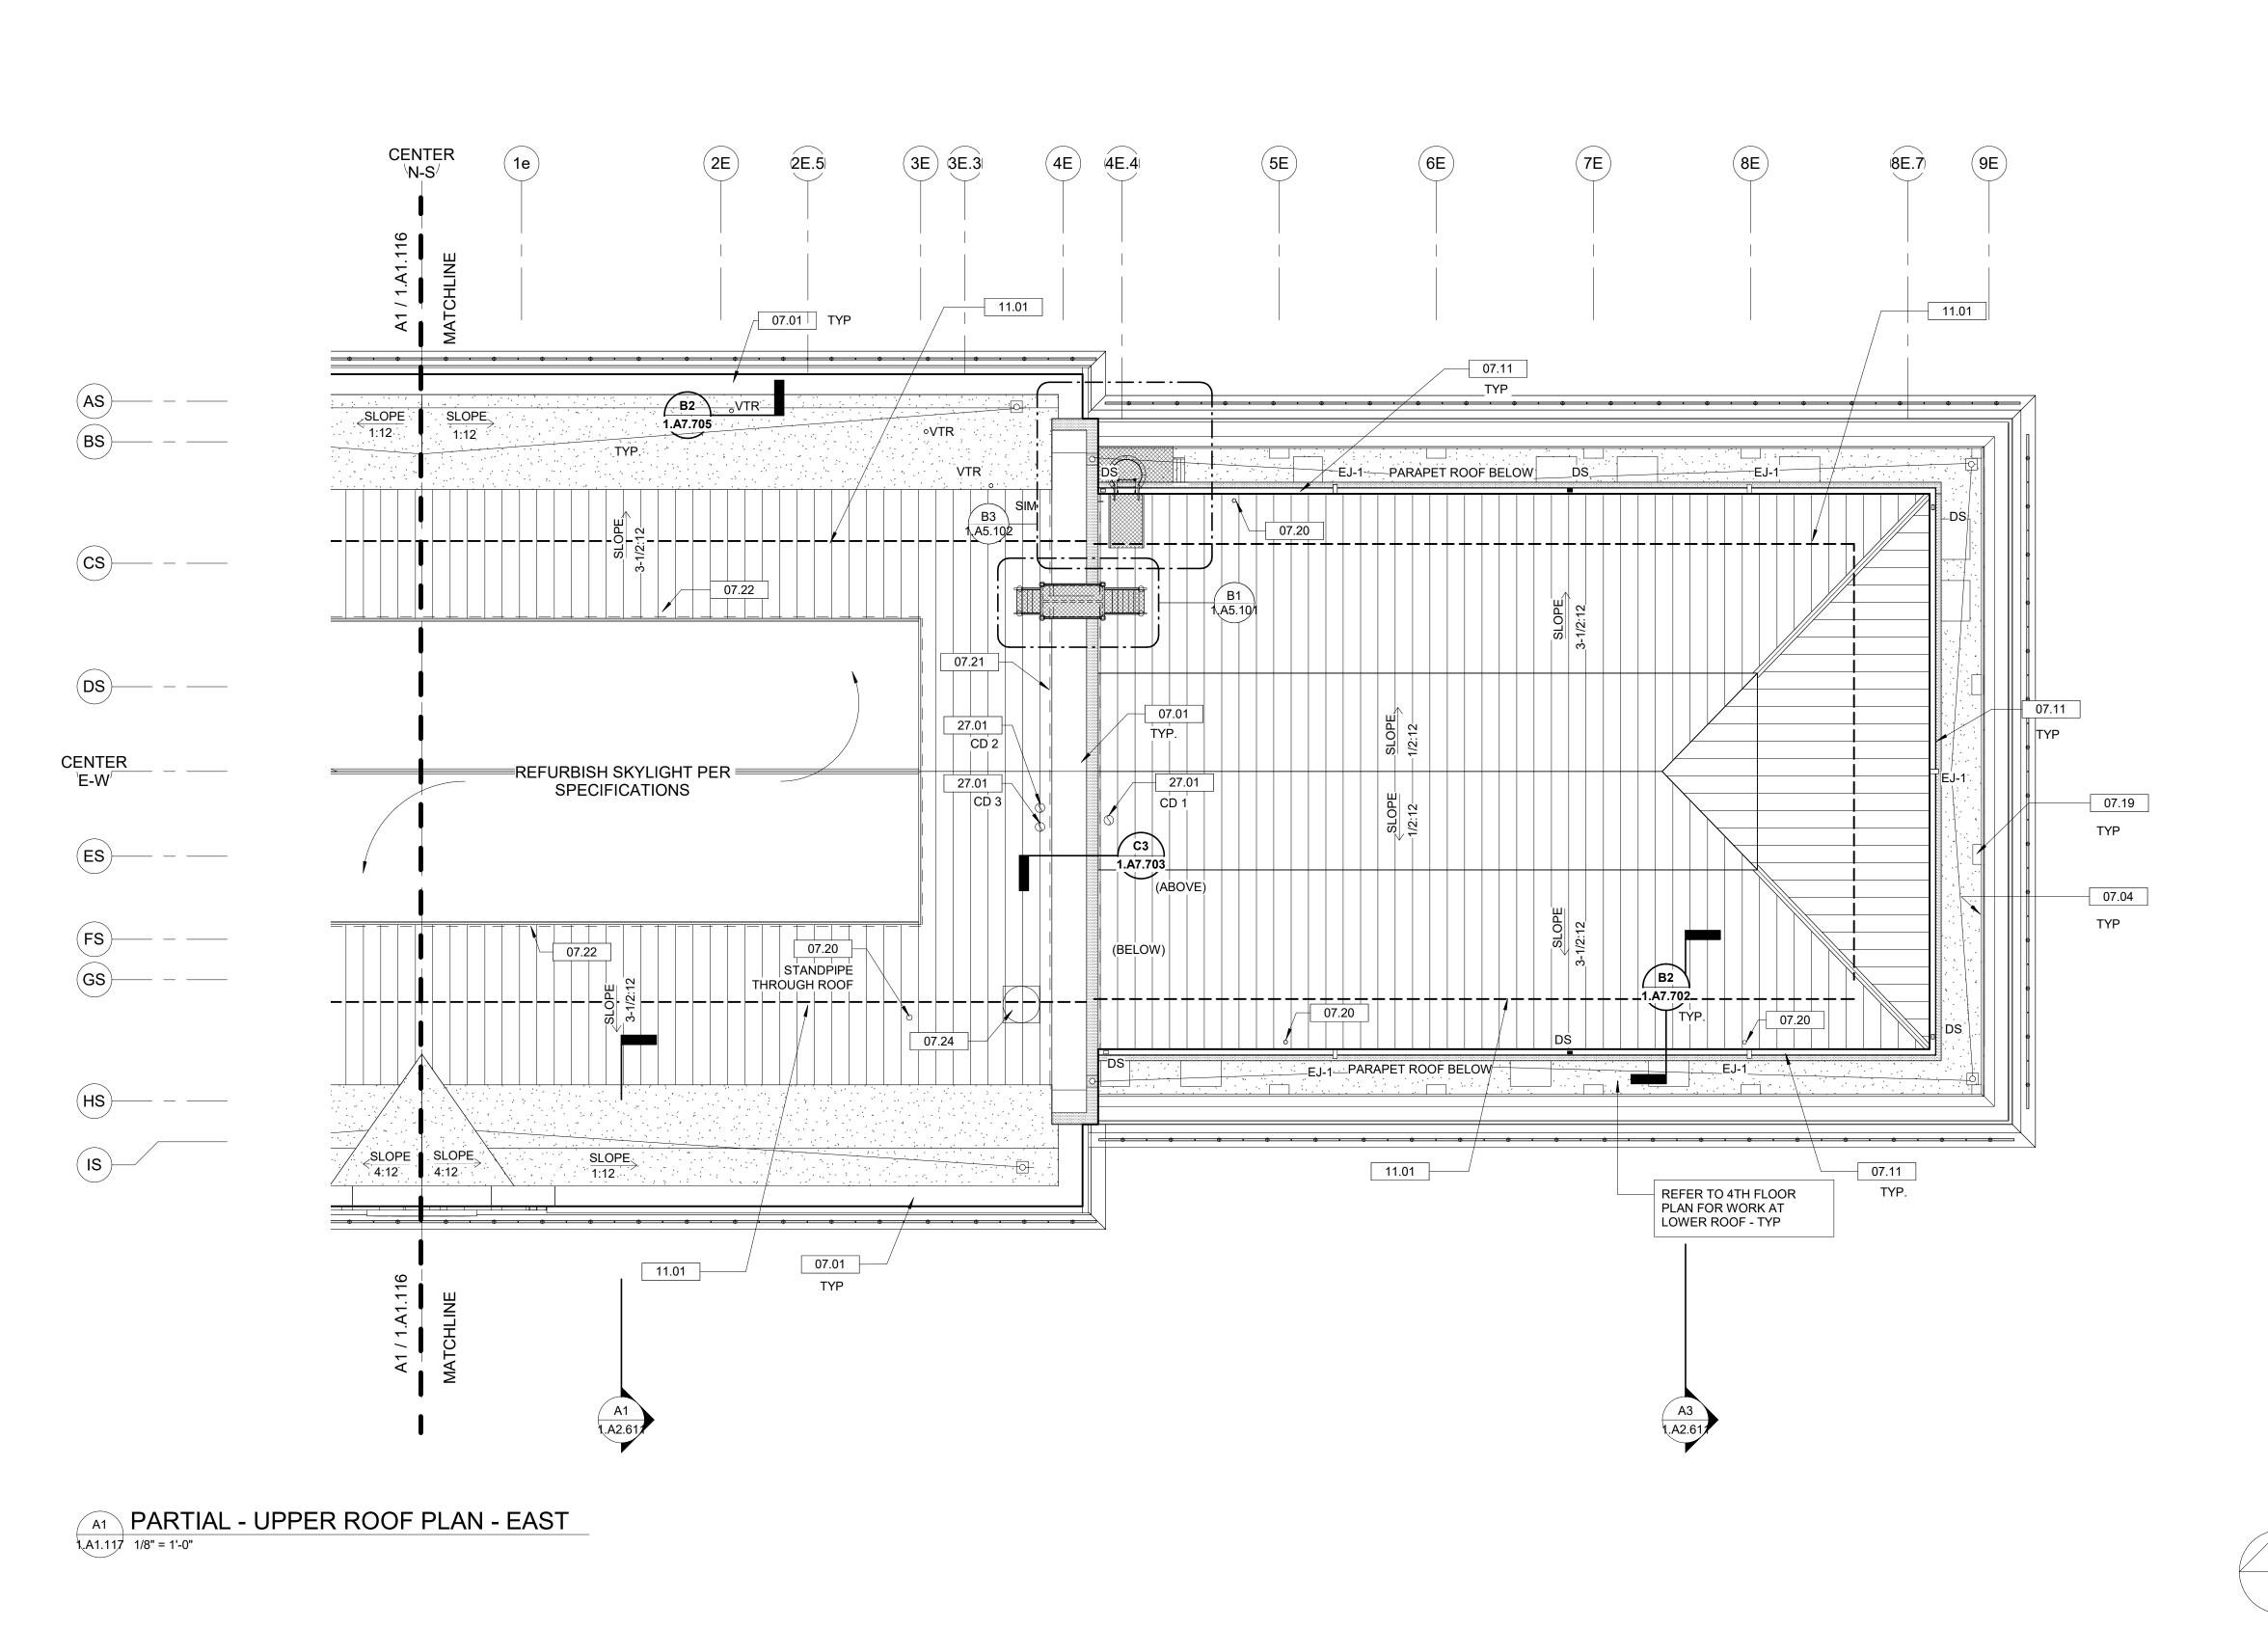

SHEET NOTES

- REFER TO SHEET 1.GO.03 FOR NEW WORK GENERAL NOTES APPLICABLE TO THE ENTIRE PROJECT
- FALL PROTECTION INFRASTRUCTURE IS TO BE BID AS A DESIGN-BUILD, **DELEGATED DESIGN SYSTEM AS FOLLOWS:**
- PROVIDE A HANDS FREE HORIZONTAL LIFELINE SYSTEM ABLE TO ACCOMMODATE USE WITH STANDARD HARNESS AND J-CLAMP EQUIPMENT, INCLUDING DOUBLE-LANYARDS AND
 - AUXILIARY BYPASS LANYARD MAXIMUM FALL ARREST FORCE: 1,800 POUNDS (816 KG) WHEN WEARING A BODY HARNESS WITH A SAFETY FACTOR OF 2 WITHOUT PERMANENT DEFORMATION, AND 5,000 POUNDS (2267 KG) AGAINST FRACTURE OR DETACHMENT
- ACCOMMODATE A CAPACITY MAXIMUM OF 2 WORKERS PER LENGTH OF CABLE BETWEEN TWO ANCHORS.
- PROVIDE ALL TURNBUCKLES, J-CLAMPS, THIMBLES, AND SHOCK ABSORBERS REQUIRED FOR COMPLETE CONTINUOUS CABLE SYSTEM THRU ANCHORS, AS SHOWN. PROVIDE ANCHOR AND CABLE SYSTEM WITH 2"-6" MAXIMUM CABLE SAG BETWEEN TWO ANCHORS.
- PROVIDE PERMANENT ANCHORS FASTENED TO BUILDING STRUCTURE AS NOTED AND DIAGRAMMED. FALL PROTECTION ANCHOR LAYOUT AND SPACING IS TO ACCOMMODATE STANDARD LANYARD LENGTHS (WITH 12 FT. EXTENSION LANYARDS AT CONCOURSE ROOF, AND ROBE GRAB EXTENSION SYSTEM AT UPPER ROOFS), AND PROVIDE REACH TO ALL ROOF SURFACES AND EDGES, INCLUDING ALL LENGTHS OF GUTTERS, DRAINS, AND EQUIPMENT, AS WELL AS ALLOW TRAVEL TO ROOF ACCESS STAIRS AND LADDERS
- CONNECTING SECTIONS / LEVELS OF ROOFS. COMPLY WITH OSHA AND OTHER AUTHORITIES HAVING JURISDICTION REQUIREMENTS, AS PART OF DESIGN-BUILD SUBMISSION, SHOP DRAWINGS SHALL BE MADE WITH CERTIFICATIONS AND ENGINEER'S SEAL

EXTERIOR ENVELOPE - CONSTRUCTION KEY NOTES

- 07.01 PROVIDE NEW CONTINUOUS METAL COPING CAP TO MATCH EXISTING PROFILE -REFER TO DETAIL.
- 07.04 PROVIDE NEW CONT METAL COPING CAP REFER TO DETAIL 07.11 PROVIDE NEW GUTTER LINING (SLOPED TO DRAINS) OVER WATERPROOFING UNDERLAYMENT, IN EXISTING BUILT-IN STONE OR CONCRETE GUTTER TO MATCH EXISTING. VERIFY EXIST. DETAILING TO BE DETERMINED FOLLOWING FIELD
- 07.19 PROVIDE NEW METAL COPING CAP AT TOP OF EXISTING BRICK COLUMN WRAP -
- 07.20 | REPAIR OR REPLACE DAMAGED OR CORRODED FLASHING AT PIPE PENETRATION |
- 07.21 REPAIR OR REPLACE DAMAGED OR CORRODED BASE FLASHING AND COUNTERFLASHING EACH SIDE OF PARAPET
- 07.22 REPAIR OR REPLACE DAMAGED OR CORRODED BASE FLASHING AND COUNTERFLASHING AT SKYLIGHT CURB
- 07.24 CURB AND COVER OVER ABANDONED SKYLIGHT TO REMAIN REPAIR FLASHINGS AS REQUIRED
- 11.01 PROVIDE FALL PROTECTION INFRASTRUCTURE AS REQUIRED. COMPLETE SYSTEM IS TO BE BID AS A DESIGN-BUILD, DELEGATED DESIGN SYSTEM. REFER TO SHEET NOTE 1 ON CONCOURSE AND UPPER ROOF PLANS FOR MORE DETAIL
- REMOVE COMMUNICATION DEVICE IF REQUIRED TO PERFORM NEW WORK AND REINSTALL MOUNTED ON VERTICAL WALL

UPPER ROOF LEGEND

1 1.A2.603

EXISTING TERNE-COATED STAINLESS STEEL STANDING SEAM ROOF TO BE REFURBISHED


PROVIDE NEW, FULLY-ADHERED 90-MIL EPDM ROOF SYSTEM ON COVER BOARD, OVER ADHERED 4" MIN. RIGID INSULATION BOARD, TAPERED & SLOPED TO DRAINS, OVER EXISTING ROOF DECK.

SLOPE DIRECTION OF ROOF SLOPE - DOWN TO DRAIN.

- ROOF DRAIN PROVIDE NEW ROOF DRAIN AT EXISTING DRAIN LOCATION. ENLARGE CORE HOLE THRU DECK TO ACCOMMODATE LARGER PIPE DIAMETER. REFER TO PLUMBING. FLASH NEW ROOF SYSTEM INTO NEW DRAIN BODIES - REFER TO A3/1.A7.705.
- EXISTING VENT THRU ROOF. PROVIDE WITH NEW PRE-MANUFACTURED EPDM PIPE FLASHING BOOT AROUND EXISTING VENT PIPE TO REMAIN AT NEW EPDM ROOFS. REPAIR OR REPLACE FLASHING AT EXISTING METAL ROOFS TO REMAIN
- NEW 3"X5" MILL DOWNSPOUT, EXTENDING 1-STORY DOWN FROM BUILT IN GUTTER AND DAYLIGHTING ONTO 4TH FLOOR PARAPET BELOW, IN SAME LOCATION AS EXISTING. REPLICATE EXISTING CONDUCTOR BOX. PROVIDE NEW DOWNSPOUT STRAPS TO MATCH EXISTING IN QUANTITY AND LOCATION - FASTEN THRU MORTAR JOINTS ONLY. REFER TO C1/1.A7.702 FOR DS OUTLET DETAIL.
- NEW 3"X5" DOWNSPOUT, EXTENDING 1-STORY DOWN FROM BUILT IN GUTTER AND DAYLIGHTING ONTO 4TH FLOOR PARAPET BELOW, IN NEW LOCATION AS SHOWN. CORE THRU AND PASS NEW DOWNSPOUT THRU EXISTING CORNICE TO MATCH ADJACENT/EXISTING DOWNSPOUT DETAILING. PROVIDE NEW CONDUCTOR BOX TO REPLICATE ADJACENT EXISTING BOXES. REFER TO C1/1.A7.702 FOR DS OUTLET DETAIL.
- EJ-1 NEW GUTTER EXPANSION JOINT REFER TO TYPICAL DETAIL.

CD-1 EXISTING COMMUNICATION DEVICE TO REMAIN

LOCATION NUMBER

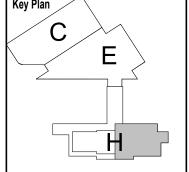

Work Elem. No: C.RE.100048

Revisions Passenger Corporation (Amtrak), Office of Engineering, and is supplied on a confidential basis solely for use in connection with the design and construction of Amtrak facilities and

Office of Engineering, is prohibited.

equipment. The reproduction, display, sale or other disposition of this document without

the express written consent of the National Railroad Passenger Corporation,

Office of Chief Engineer STRUCTURES National Railroad Passenger Corporation 30th Street Station, Philadelphia, Pennsylvania 19104

PENN STATION PARTNERS, LLC 1300 Thames Street, Suite 10 Baltimore, MD 21231 United States Tel 410.123.4567 Fax 410.123.4567

100 North Charles Street,14th Floor

Baltimore, MD 21201

Tel 410.576.0440

1300 North 17th Street, Suite 1000

Arlington, VA 22209

BALTIMORE **EXTERIOR ENVELOPE - EARLY RELEASE**

MARYLAND **HEADHOUSE REHABILITATION**

Sheet name: **ROOF PLAN - EAST**

60% SUBMISSION DRAFT Designed Designer Drawn Author Checked Checker Date 10/9/20

🖆 1.A1.117

